# **CO-LIVING - ALTERATIONS AND ADDITIONS**

**DA SUBMISSION** 

# 1246 Canterbury Road, Roselands NSW 2196

PROJECT NO. 21433

No.	DRAWING NAME
DA_000.	COVER SHEET
DA_001.	SECTION J
DA_100.	SITE PLAN & ANALYSIS
DA_102.	SEDIMENT CONTROL PLAN
DA_200.	GROUND FLOOR PLAN
DA_201.	FIRST FLOOR PLAN
DA_202.	SECOND FLOOR PLAN
DA_203.	ROOF PLAN
DA_300.	ELEVATIONS
DA_302.	STREETSCAPE
DA_400.	SECTION
DA_500.	CALCULATIONS - GFA
DA_600.	SHADOWS - PLAN
DA_701.	3D VISUAL
DA_800.	NOTIFICATION PLAN

### **CANTERBURY - BANKSTOWN DCP & LEP**

Land Zoning: B2 - Local Centre

566.6 m<sup>2</sup> Site Area:

LOT / DP: Lot 1 DP 19122

STANDARD	REQUIREMENTS	PROVIDED	COMPLIES	
FSR (m <sup>2</sup> ):	NIL	Total FSR - TBC m <sup>2</sup>	YES	
Maximum Building Height:	18m	11.5m	YES	

STANDARD	REQUIREMENTS	PROVIDED	COMPLIES	
Solar Access	3 Hours between 9am and 3pm to communal living area	TBC	YES	
COS (Common Terrace)	TBCm² required.	TBCm <sup>2</sup>	YES	
Manager's POS	TBCm² required. TBCm²		YES	
Car Parking	0.5 Car Spaces per Boarding Rooms - TBC  1 Parking Space for Manager - TBC  1 Commercial Parking - TBC  Total - TBC		Refer to SEE	
Bicycle & Motor Bike Parking	1 Bicycle per 5 Board Rooms - TBC TBC  1 Motor Bike per 5 Board Rooms - TBC		YES	
Min. Room Sizes	Single - 12m² required.  Double - 16m² required.			
Max. Room Sizes	25m² required.	25m² required.		
Communal Living Area	Yes, when more than 5 Board Rooms.	ian 5 Board Rooms. TBC Y		
Manager's Room	Yes, when more than 20 Board Rooms	TBC	YES	





NOTE

ISSUE DATE PURPOSE OF ISSUE

STATUS **PROJECT** 1246 CANTERBURY ROAD, FOR APPROVAL **ROSELANDS NSW 2196** 

STAGE DA

DRAWING NO. **DA-000** SCALE

1:50

ISSUE Α

JOB NO. 21433

CHECKED BY RΖ

DRAWN BY

CLIENT

DATE DRAWING TITLE 03.03.2025 **Cover Sheet** 



### **Proposed Boarding House** 1246 Canterbury Road Roselands 2196

#### STATEMENT OF COMPLIANCE

The design documentation as referred to in this report has been assessed against the applicable provisions of Section J of the National Construction Code (NCC2022) and it is considered that such documentation complies with or is capable of complying (as outlined above) with that Code (NCC2022).

The proposed building fabric and glazing requirements are analysed using the SPECKEL software (Clauses J4D4 Roof and ceiling construction, J4D5 Roof lights, J4D6 Walls and glazing and J4D7 Floors). Please note that while the remaining parts J5 to J9 are listed in this report as requirements from the NCC, their implementation falls under the purview of competent and licensed professionals, such as engineers and

Overall, the building will comply with the applicable provisions of Section J of the NCC2022, with each professional responsible for ensuring compliance with the relevant clauses of the code in their respective fields.

Assessor: Zoran Cvetkovski Thermal Performance Assessor B.Eng.







Sustainability-Z sustainability-z@outlook.com

### Conclusions

SUMMARY OF SOLUTIONS TO COMPLY WITH SECTION J PERFORMANCE **REQUIREMETS DTS Method (NCC2022)** 

The following table is a summary of the requirements for compliance with Section J.

Clause-Description	Status				
Part J1 Energy efficiency	Table of NCC requirements				
performance requirements	Wall Type	R-Value m <sup>2</sup> K°/W	Solar Absorptance		
	External	1.4	0.6		
	(applicable to new walls only)				
	Floor Type	R-Value m <sup>2</sup> K°/W	Solar Absorptance		
	Bottom	2	1-		
	External	2	-		
	(a	pplicable to new floors or	nly)		
	Roof Type	R-Value m <sup>2</sup> K°/W	Solar Absorptance (Max)		
	External	3.7	0.45		
	(;	applicable to new roofs o	nly)		
Roof and wall thermal break	equipment.  The roof and the wall thermal bridges are analyzed with SPECKEL thermal bridge calculator. The calculation is attached to the report in the section (Speckel).				
PART J4 Building fabric.					
J4D3 Thermal construction — general	a. abuts or overlar members such a where the insulab. forms a continu the like that inh c. does not affect (2) Where required, refl a. the necessary ai	alation must comply with A  sa adjoining insulation other as studs, noggings, joists, fu  ation must be against the me ous barrier with ceilings, we erently contribute to the the the safe or effective operation ective insulation must be in rspace to achieve the requir of the reflective insulation and	than at supporting rring channels and the likember; and alls, bulkheads, floors or rmal barrier; and on of a service or fitting. stalled with—		
	cladding; and b. the reflective insulation closely fitted against any penetration, door or window opening; and				


NCC 2022 Volume One - Building Code of Australia Class 2 to 9 buildings



- c. the reflective insulation adequately supported by framing members;
- d. each adjoining sheet of roll membrane being- overlapped not less than 50 mm; or
  - taped together.
- (3) Where required, bulk insulation must be installed so that-
- a. it maintains its position and thickness, other than where it is compressed between cladding and supporting members, water pipes, electrical cabling or the like; and
- b. in a ceiling, where there is no bulk insulation or reflective insulation in the wall beneath, it overlaps the wall by not less than 50
- (4) Roof, ceiling, wall and floor materials, and associated surfaces are deemed to have the thermal properties listed in Specification 36.
- (5)The required Total R-Value and Total System U-Value, including allowance for thermal bridging, must be-
- a. calculated in accordance with AS/NZS 4859.2 for a roof or floor; or
- b. determined in accordance with Specification 37 for wall-glazing construction; or
- c. determined in accordance with Specification 39 or Section 3.5 of CIBSE Guide A for soil or sub-floor spaces.

The clauses J4D4 Roof and ceiling construction, J4D5 Roof lights, J4D6 Walls and glazing and J4D7 Floors are assessed with the Speckel software and the NCC Façade Calculator, and the results are summarized in the

Below is given only one option, how the NCC requirements for the building elements can be met. Any other solution meeting the values of NCC requirement table (Page 3 of the report) is acceptable.

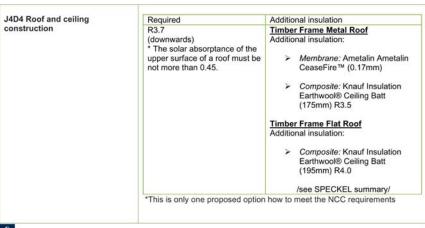

NCC 2022 Volume One - Building Code of Australia Class 2 to 9 buildings

309A Forest Rd Hurstville NSW 2220 ph: +61 2 8098 7886 fx: +61 2 8098 7886 e: admin@zta.net.au ZT ARCHITECTS PTY LTD ABN 87 655 327 049



NOTE

ISSUE DATE PURPOSE OF ISSUE

PROJECT 1246 CANTERBURY ROAD. **ROSELANDS NSW 2196** 

4

CLIENT

STATUS

STAGE DA

FOR APPROVAL

DRAWING NO. **DA-001 SCALE** 

Α JOB NO. 21433


**ISSUE** 

WB **CHECKED BY** RΖ

DRAWN BY

DATE 03.03.2025

DRAWING TITLE Section J

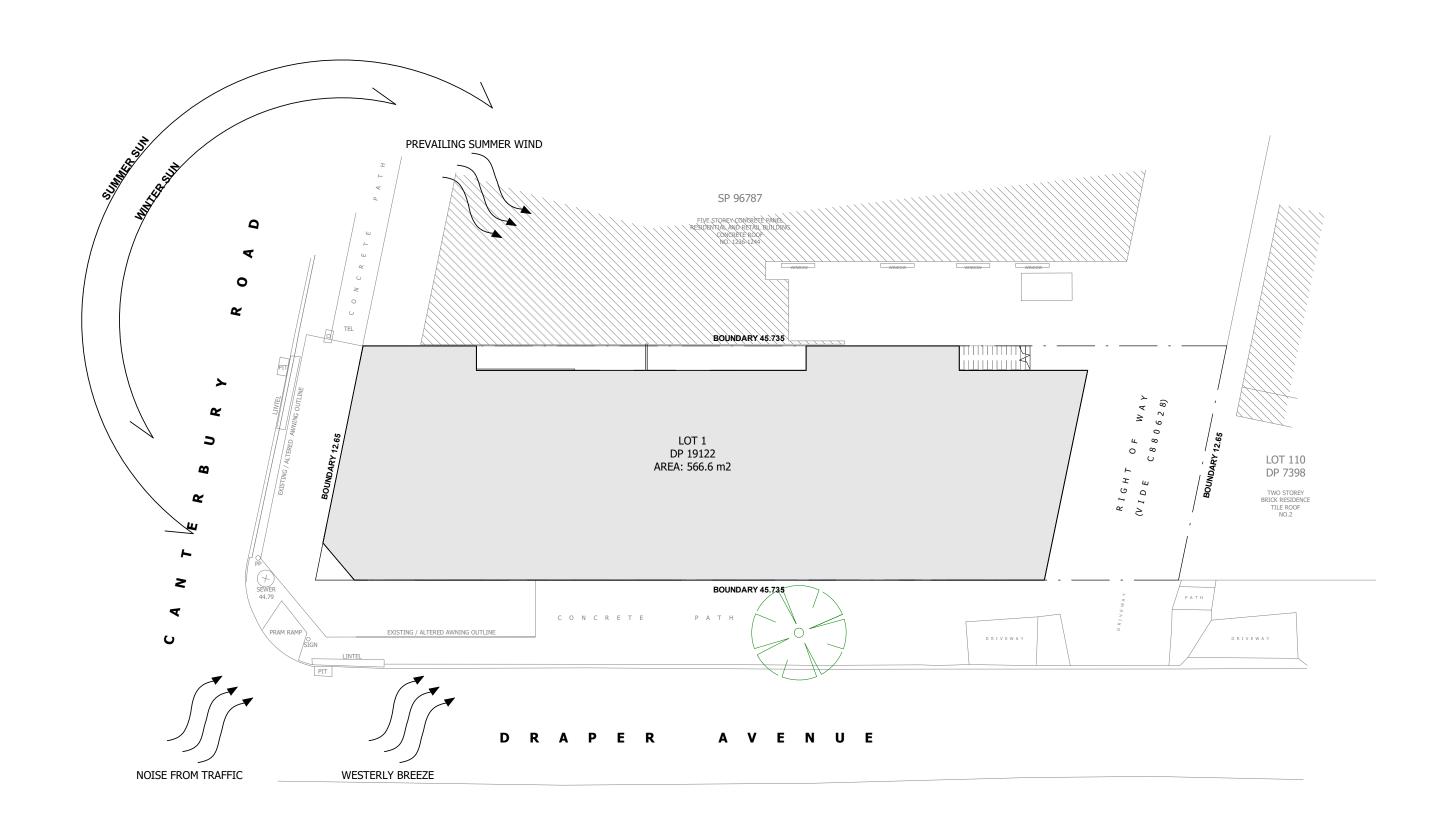



ACCREDITED BUILDING DESIGNER

NOTE

ISSUE DATE PURPOSE OF ISSUE

**PROJECT** 1246 CANTERBURY ROAD, ROSELANDS NSW 2196

CLIENT

STATUS

FOR APPROVAL

STAGE DA

DRAWING NO. **DA-100** 

SCALE

1:200


DATE

03.03.2025

ISSUE DRAWN BY WB Α

JOB NO. CHECKED BY 21433 RΖ

DRAWING TITLE Site Plan & Analysis

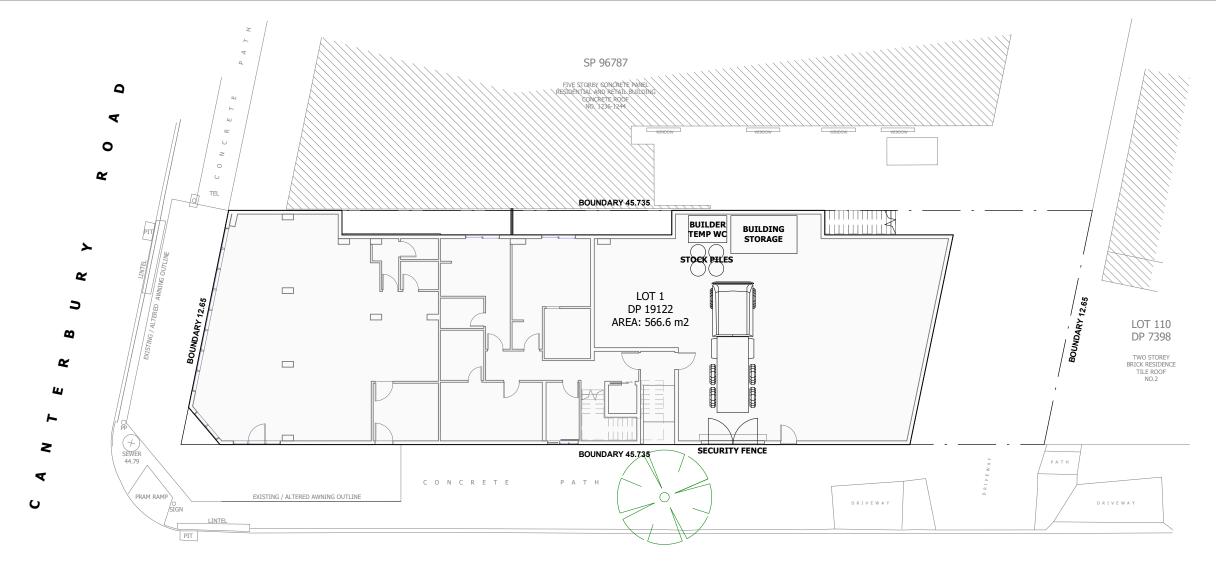

## **SOIL AND WATER MANAGEMENT NOTES**

SITE MANAGER

01. ALL EROSION AND SEDIMENT CONTROL MEASURES TO BE INSPECTED AND SITE SHALL BE PROTECTED FROM MAINTAINED DAILY BY

02. MINIMISE DISTURBED AREAS

03. ALL STOCKPILES TO BE CLEAR FROM DRAINS, GUTTERS AND FOOTPATHS.

04. DRAINAGE TO BE CONNECTED TO STORMWATER SYSTEM AS SOON AS POSSIBLE.

05. ROADS AND FOOTPATHS TO BE SWEPT DAILY AND KEPT CLEAN AT ALL TIMES

10. THE STREET DRAINAGE PIT LOCATED DOWNHILL OF THE

DRAPER

SEDIMENT WITH HAY BALES. 11. A SINGLE CONSTRUCTION

ENTRANCE SHALL BE ESTABLISHED IN THE MANNER SHOWN IN THE ATTACHED DETAILS.

12. THIS DRAWING SHALL BE READ IN CONJUNCTION WITH ARCHITECTURAL AND STRUCTURAL ENGINEERING DOCUMENTS. ANY DISCREPANCIES SHALL BE REPORTED BY THE BUILDER TO THE ARCHITECT PRIOR TO COMMENCEMENT OF THE ITEM.


13. IF IN DOUBT, ASK THE SUPERINTENDENT WHO SHALL CONSULT THE DESIGNER.

100 TO 150 HARDCORE OR ROADBASE TO DELIVERY AREA TO PREVENT SOIL GUTTER LAYBACK FOOTPATH MIN 6M FIT POLUUTION CONTROL SAND BAG IN DOWN STREAM SIDE OF GUTTER.

E N U E

A V

SECTION THRU UNLOADING DRIVEWAY

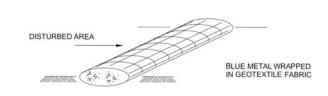

SEDIMENT BARRIER N.T.S.

DRIVEN 600mm INTO NATURAL GROUND WHERE SHOWN GEOTEXTILE FABRIC TIED TO POSTS LAPPED ONLY AT POSTS HOLD FABRIC IN PLACE NATUR GROUND

1800mm STAR PICKETS ATAPROX. 2500mm CENTRES

SECTION THRU TYPICAL SEDIMENT CONTROL FENCING

DROP INLET PIT WITH GRATE STRAW BALES STACKED / WITH 2 STAKES PER BALE

**SCALE 1:200** 

STRAW BALE DROP INLET SEDIMENT TRAP



309A Forest Rd, Hurstville NSW 2220 ph: +61 2 8098 7886 fx: +61 2 8098 7886 e: admin@zta.net.au ZT ARCHITECTS PTY LTD

ABN 87 655 327 049

ACCREDITED BUILDING DESIGNER NOTE

ISSUE PURPOSE OF ISSUE DATE

**PROJECT** 1246 CANTERBURY ROAD, **ROSELANDS NSW 2196** 

CLIENT

STAGE DA

STATUS DRAWING NO. FOR APPROVAL

**DA-102 SCALE** 1:200


JOB NO. 21433

**ISSUE** 

WB Α CHECKED BY RΖ

DRAWN BY

DATE DRAWING TITLE 03.03.2025 **Sediment Control Plan** 

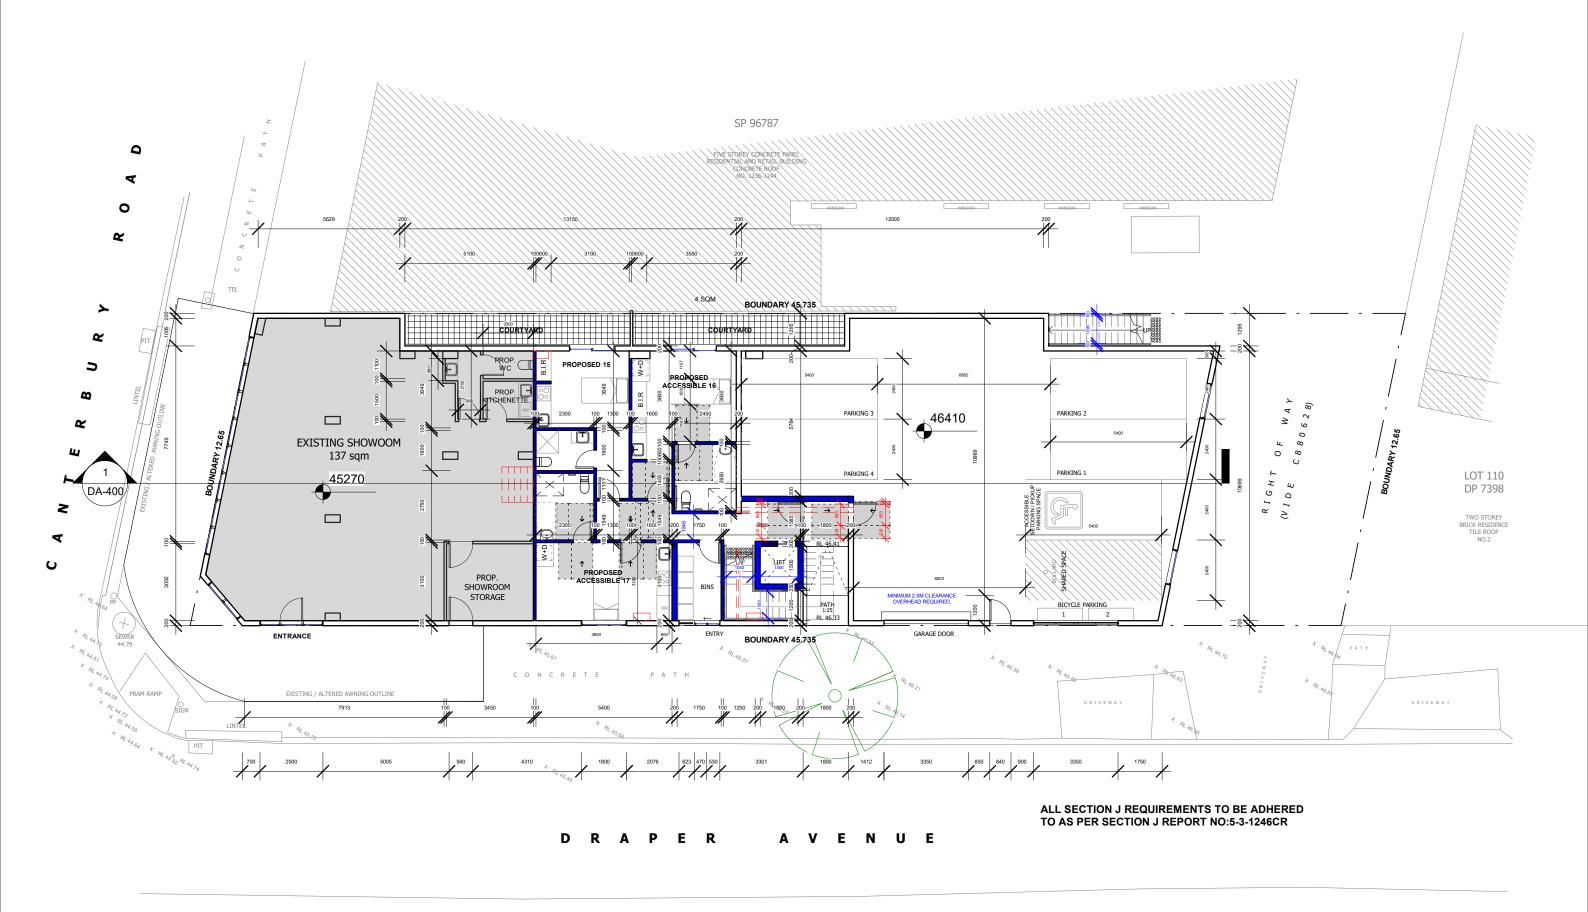



309A Forest Rd, Hurstville NSW 2220 ph: +61 2 8098 7886 fx: +61 2 8098 7886 e: admin@zta.net.au ZT ARCHITECTS PTY LTD ABN 87 655 327 049

ACCREDITED BUILDING DESIGNER NOTE

ISSUE DATE PURPOSE OF ISSUE PROJECT 1246 CANTERBURY ROAD, ROSELANDS NSW 2196

CLIENT

STATUS FOR APPROVAL

STAGE DA

DRAWING NO. **DA-200** SCALE

1:150

DATE

WB Α JOB NO. CHECKED BY 21433 RΖ

DRAWN BY

DRAWING TITLE 03.03.2025 **Ground Floor Plan** 

ISSUE



TO AS PER SECTION J REPORT NO:5-3-1246CR

#### DRAPER AVENUE





NOTE

ISSUE DATE PURPOSE OF ISSUE PROJECT 1246 CANTERBURY ROAD, **ROSELANDS NSW 2196** 

STATUS FOR APPROVAL

STAGE DA

DRAWING NO. **DA-201** 


SCALE 1:150 DATE

ISSUE DRAWN BY WB Α JOB NO. CHECKED BY 21433 RΖ

DRAWING TITLE 03.03.2025 First Floor Plan

architecture / urban design / interior design

CLIENT

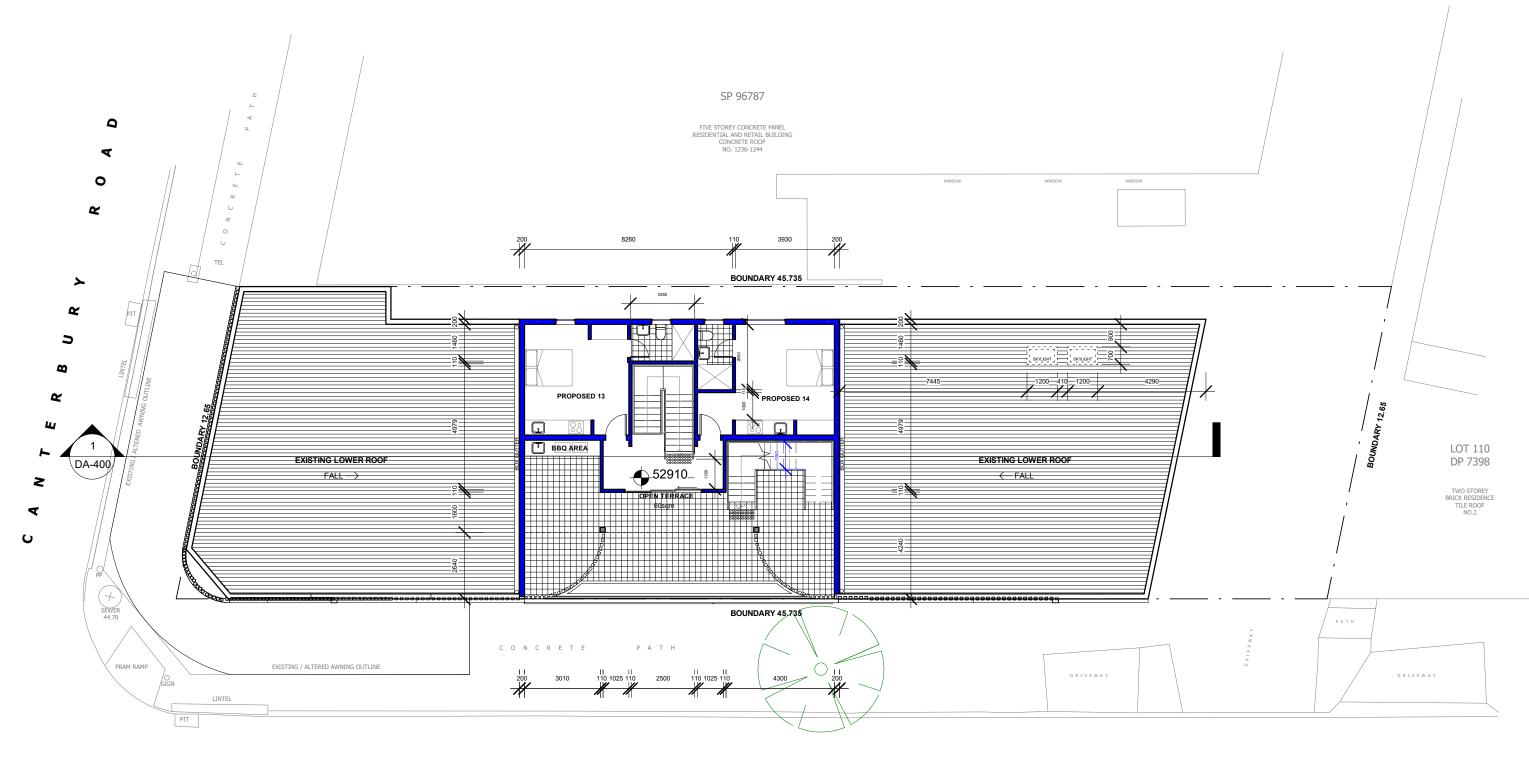

ALL SECTION J REQUIREMENTS TO BE ADHERED TO AS PER SECTION J REPORT NO:5-3-1246CR

#### DRAPER A V E N U E



ACCREDITED BUILDING DESIGNER NOTE

ISSUE DATE PURPOSE OF ISSUE PROJECT 1246 CANTERBURY ROAD, ROSELANDS NSW 2196

CLIENT

STATUS FOR APPROVAL

STAGE DA

DRAWING NO. DA-202 SCALE 1:150

Α JOB NO. 21433

ISSUE


CHECKED BY RΖ

DRAWN BY

WB

DATE 03.03.2025

DRAWING TITLE **Second Floor** 

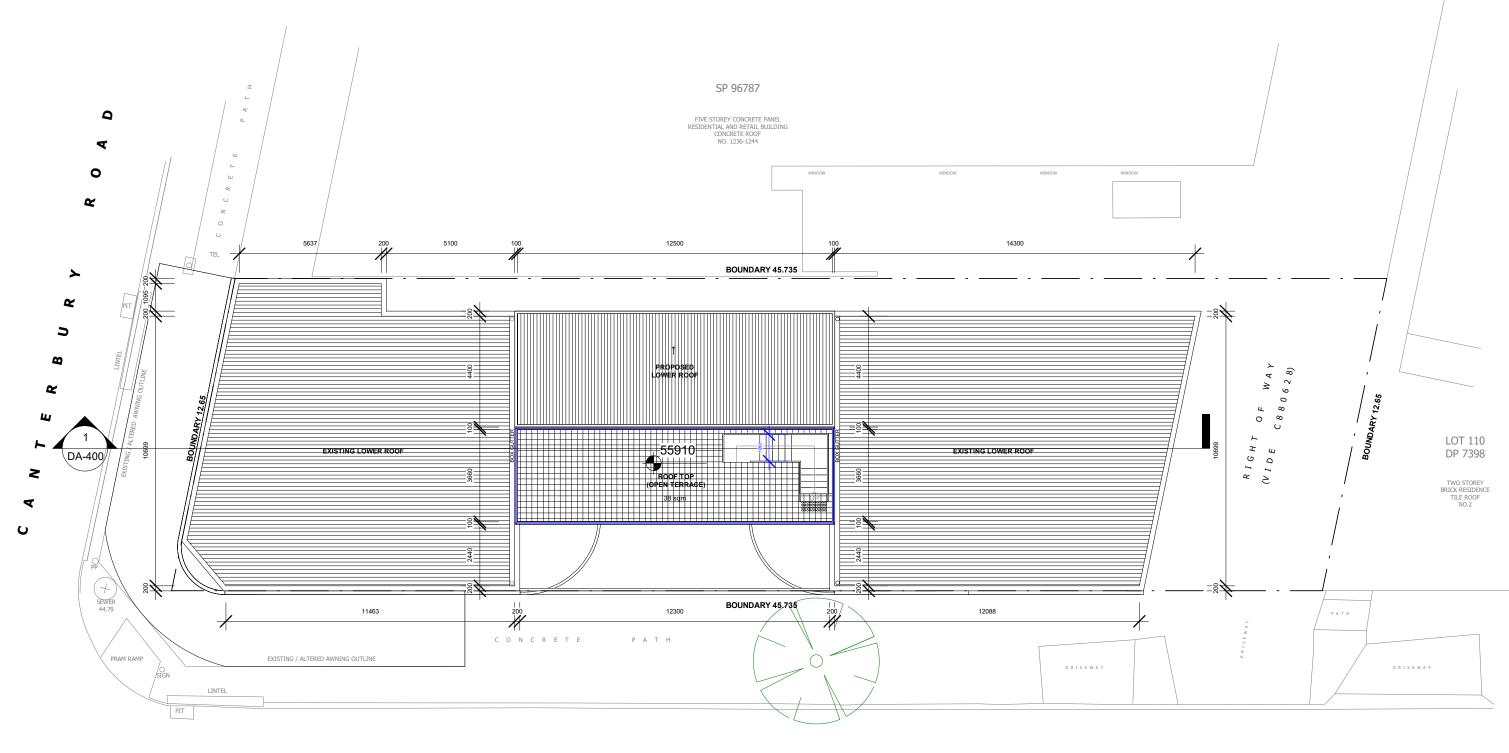

ALL SECTION J REQUIREMENTS TO BE ADHERED TO AS PER SECTION J REPORT NO:5-3-1246CR

#### D R A P E R AVENUE

ISSUE



ACCREDITED BUILDING DESIGNER NOTE

DATE PURPOSE OF ISSUE PROJECT 1246 CANTERBURY ROAD, ROSELANDS NSW 2196

CLIENT

STATUS FOR APPROVAL

STAGE

DA

DRAWING NO. **DA-203** SCALE 1:150


DATE

03.03.2025

21433 DRAWING TITLE

**Roof Plan** 

ISSUE DRAWN BY WB Α JOB NO. CHECKED BY RΖ

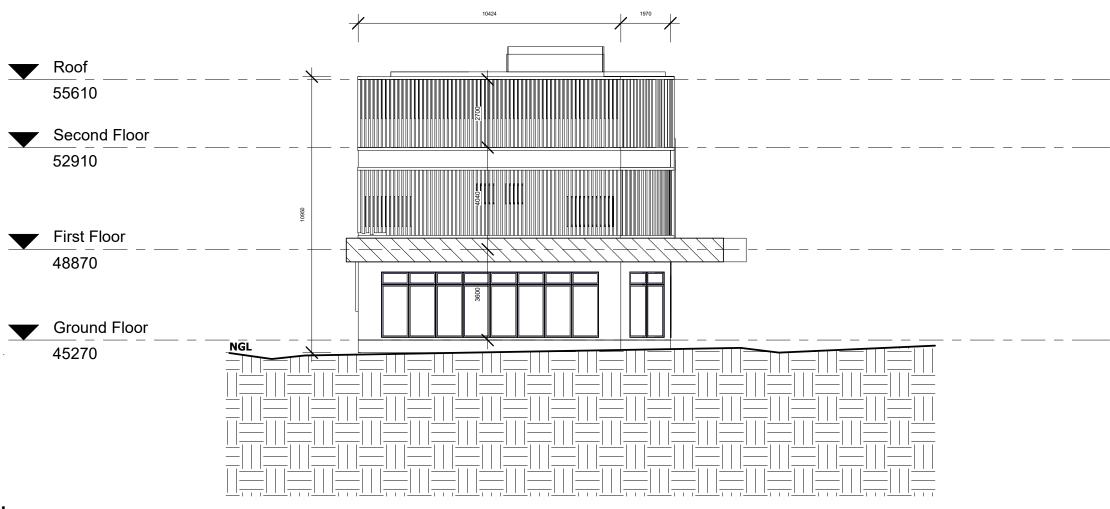

## **NORTH ELEVATION**



309A Forest Rd, Hurstville NSW 2220 ph: +61 2 8098 7886 fx: +61 2 8098 7886

e: admin@zta.net.au ZT ARCHITECTS PTY LTD ABN 87 655 327 049

ACCREDITED BUILDING DESIGNER NOTE

ISSUE DATE PURPOSE OF ISSUE

PROJECT 1246 CANTERBURY ROAD, ROSELANDS NSW 2196

CLIENT

STATUS

FOR APPROVAL

STAGE DA

DRAWING NO. **DA-300** 

1:150

DATE

03.03.2025

SCALE

ISSUE Α


WB JOB NO. CHECKED BY

RΖ

DRAWN BY

21433 DRAWING TITLE

**Elevations** 

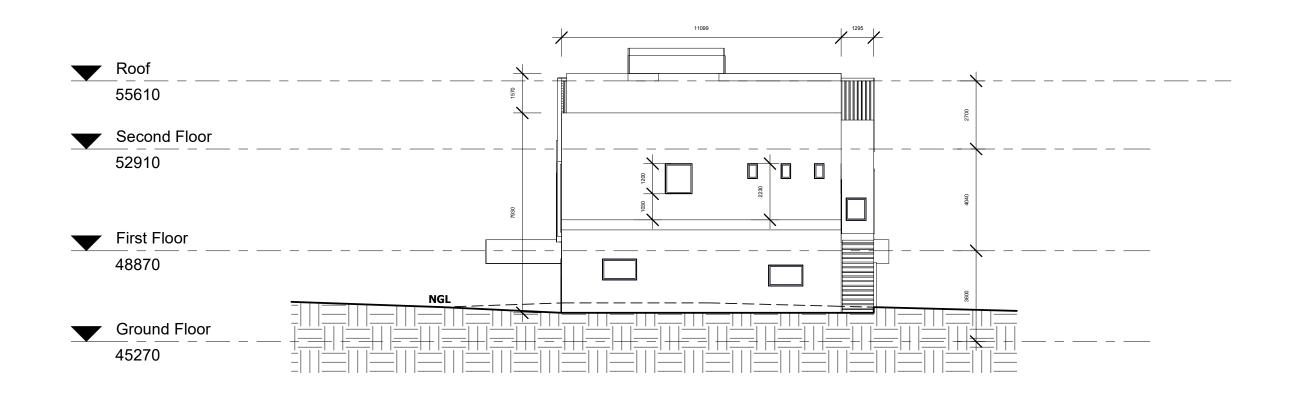

# **SOUTH ELEVATION**





NOTE

ISSUE DATE PURPOSE OF ISSUE

PROJECT
1246 CANTERBURY ROAD,
ROSELANDS NSW 2196

CLIENT

STATUS
FOR APPROVAL
STAGE

DA

OVAL DA-300.1

SCALE
1:150

DRAWING NO. ISSUE

DA-300.1

SCALE

JOB NO.


DRAWN BY
WB
CHECKED BY

RΖ

DATE **03.03.2025**  21433

DRAWING TITLE

Elevations

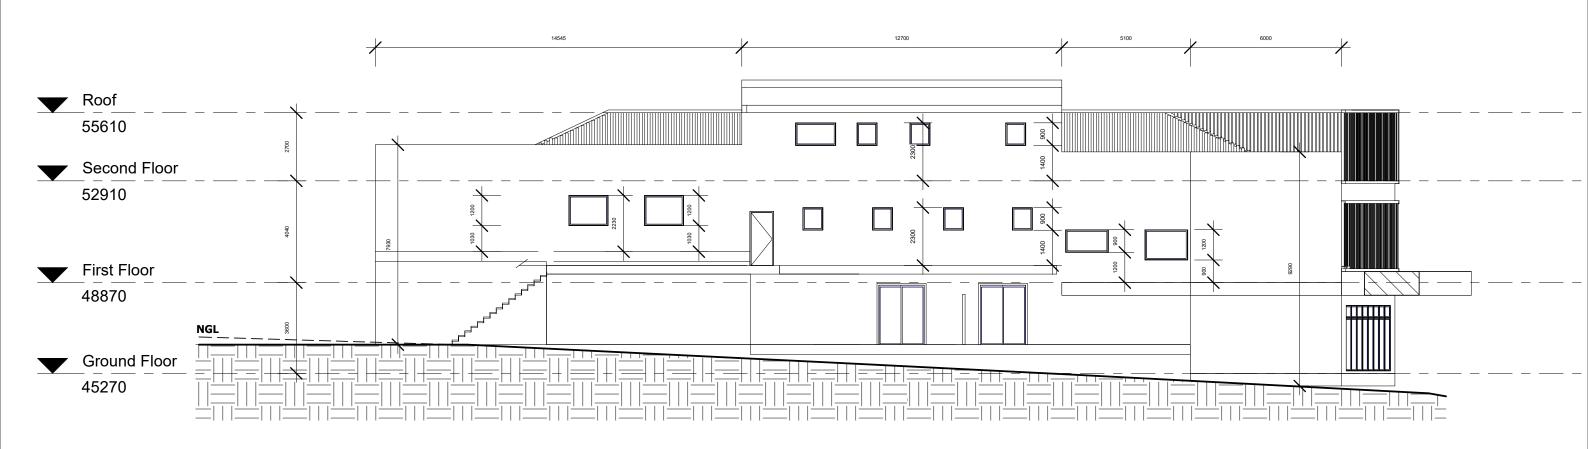

# **EAST ELEVATION**




DRAWN BY

CHECKED BY

WB

RΖ

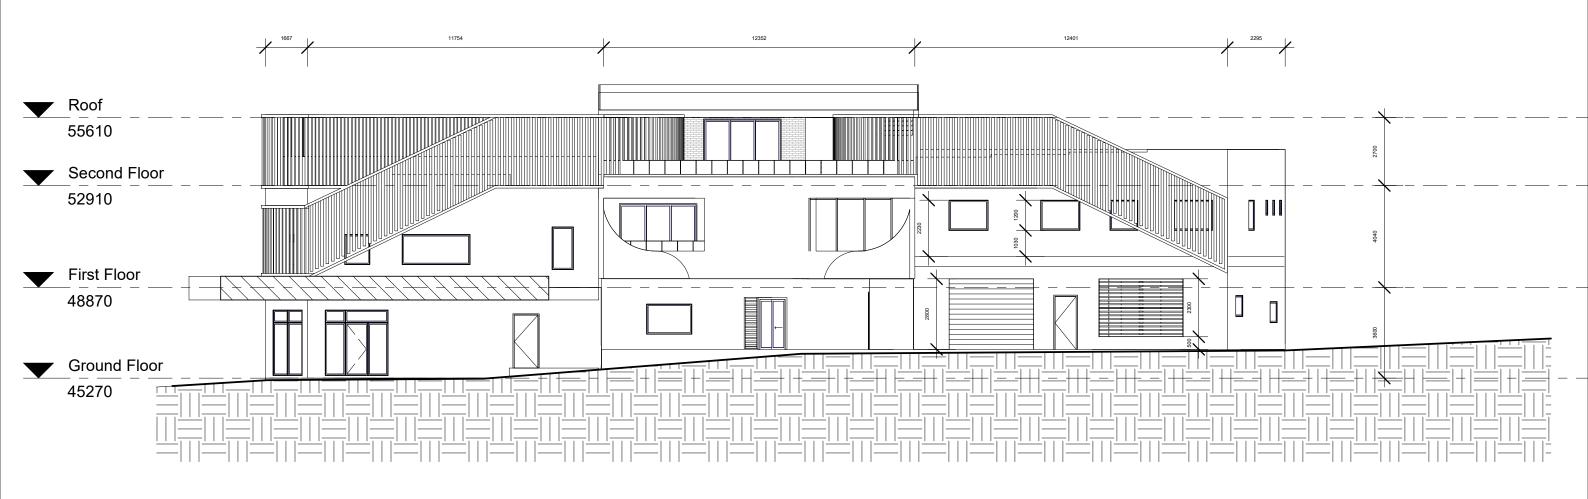

# **WEST ELEVATION**





ISSUE

DATE

PURPOSE OF ISSUE

**PROJECT** 1246 CANTERBURY ROAD, ROSELANDS NSW 2196

STATUS FOR APPROVAL

STAGE DA

DRAWING NO. DA-300.3

SCALE

ISSUE DRAWN BY WB Α CHECKED BY JOB NO. 21433 RΖ

architecture / urban design / interior design


NOTE

CLIENT


DATE 03.03.2025

1:150

DRAWING TITLE **Elevations** 

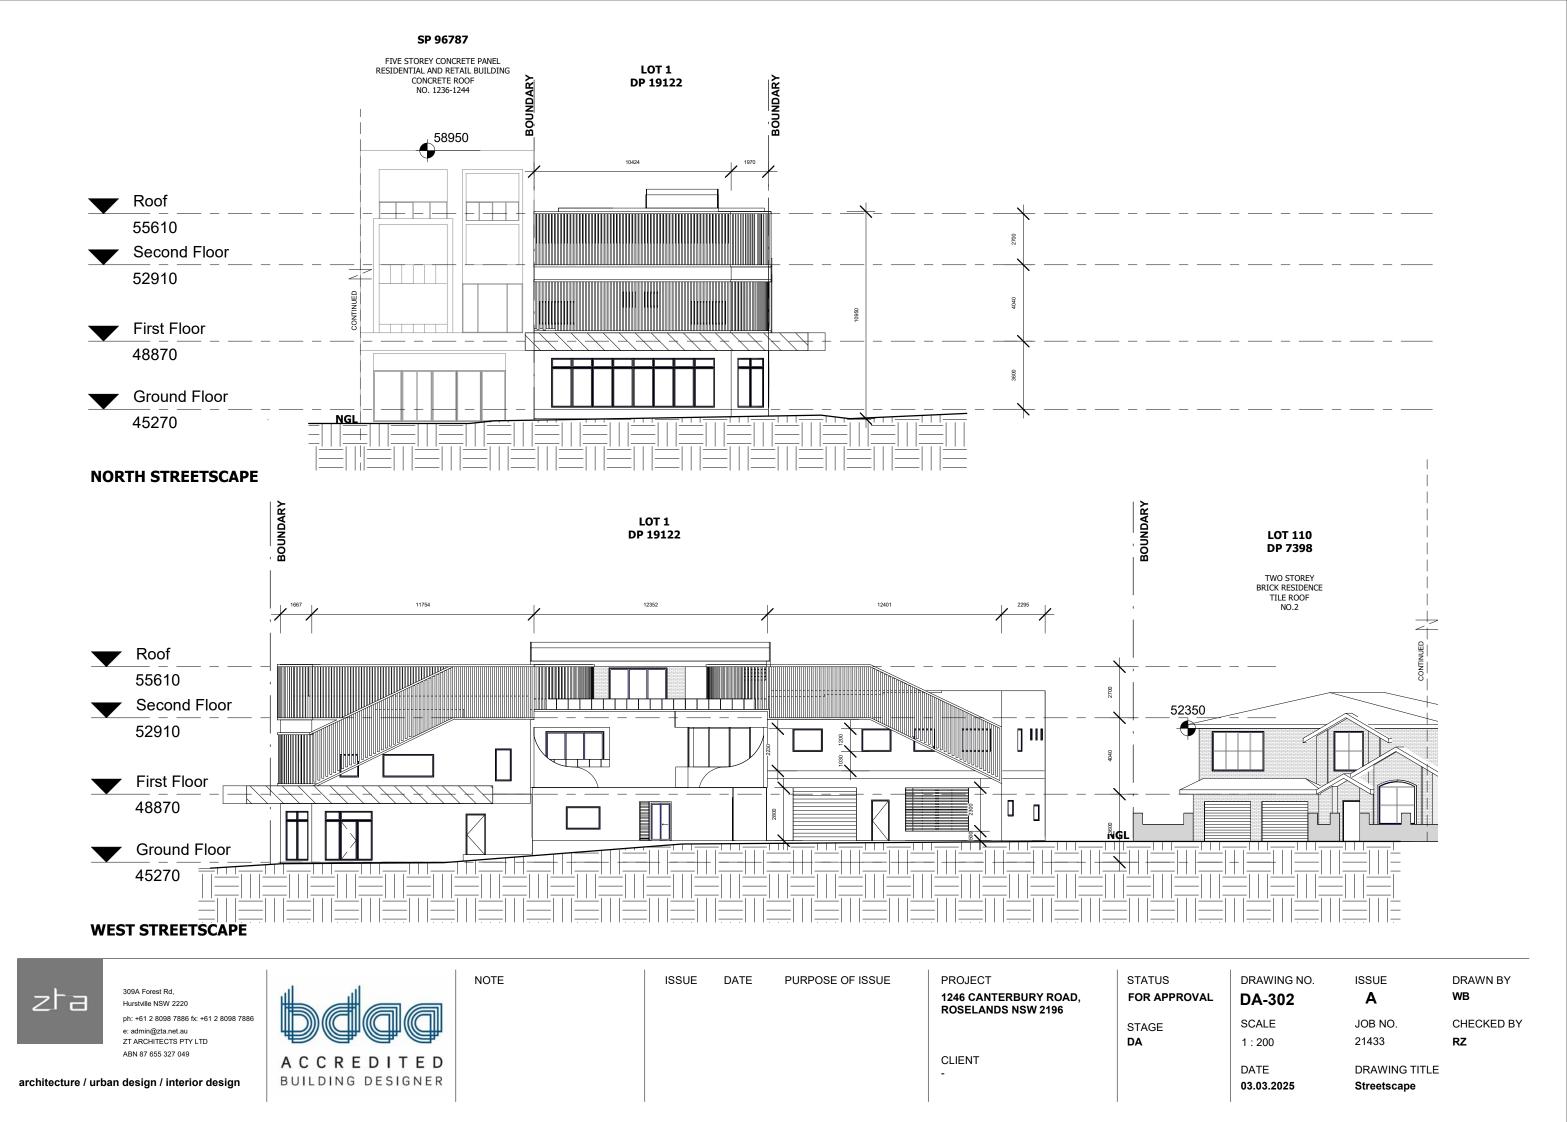

### 18M MAXIMUM BUILDING HEIGHT

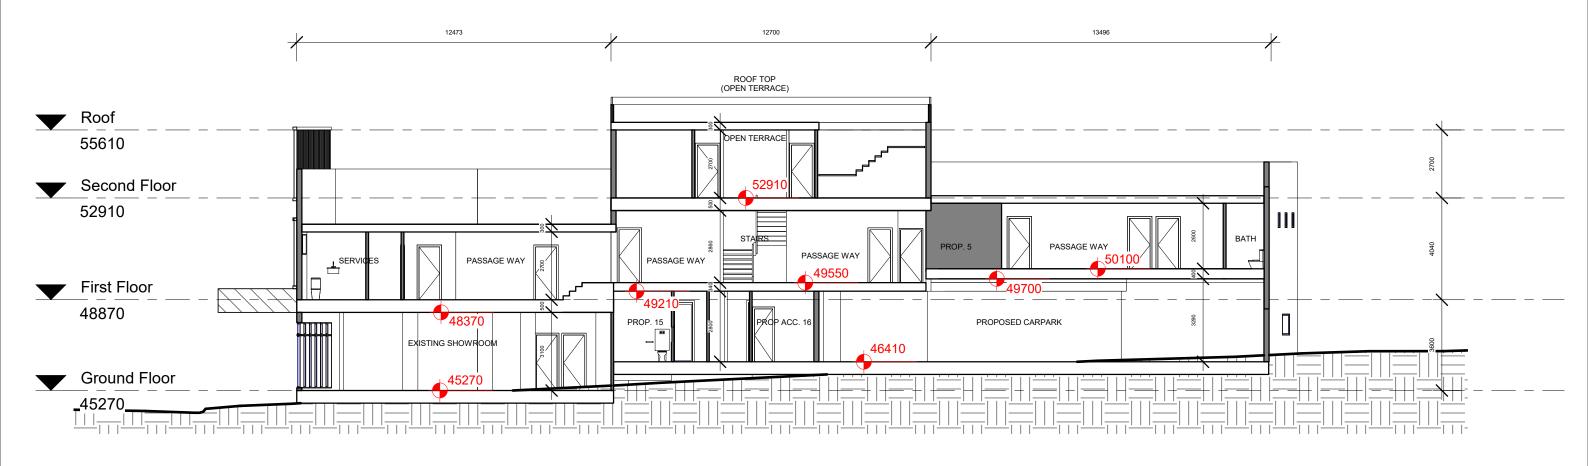



309A Forest Rd,
Hurstville NSW 2220
ph: +61 2 8098 7886 fx: +61 2 8098 7886
e: admin@zta.net.au
ZT ARCHITECTS PTY LTD
ABN 87 655 327 049

A C C R E D I T E D BUILDING DESIGNER NOTE

ISSUE DATE PURPOSE OF ISSUE

PROJECT 1246 CANTERBURY ROAD, ROSELANDS NSW 2196

CLIENT

STATUS FOR APPROVAL

STAGE DA

DRAWING NO.
DA-400
SCALE
1:150

A JOB NO.

21433


DRAWN BY
WB
CHECKED BY

RΖ

DATE 03.03.2025

DRAWING TITLE


Section

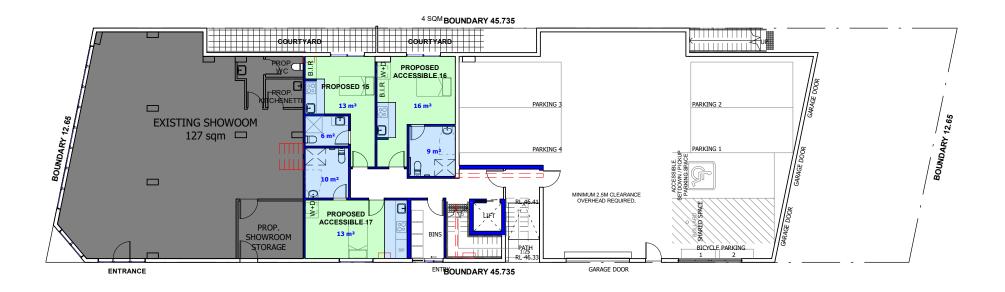

# UNIT SCHEDULE GROUND FLOOR

PROPOSED NO.	TYPE	INTERNAL AREA	ROOM AREA	WET AREA
15	SINGLE	19m²	13m²	6m <sup>2</sup>
16	SINGLE	25m <sup>2</sup>	16m²	9m²
17	SINGLE	23m <sup>2</sup>	13m <sup>2</sup>	10m <sup>2</sup>


### **GROUND FLOOR - AREA CALCULATIONS**

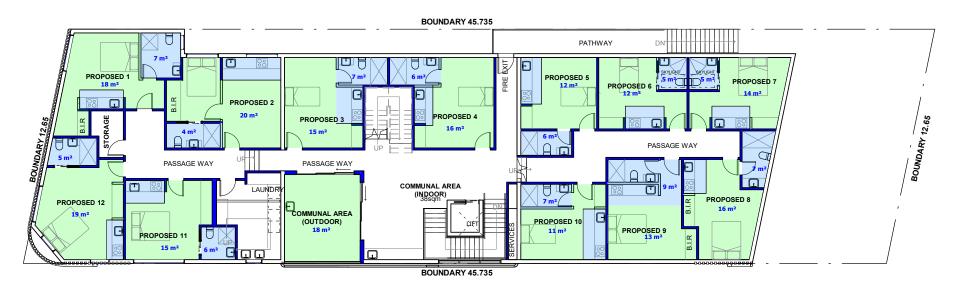

# UNIT SCHEDULE FIRST FLOOR

PROPOSED N	O. TYPE	INTERNAL AREA	ROOM AREA	WET AREA
1	DOUBLE	25m²	18m²	7m²
2	SINGLE	24m²	20m²	4m²
3	SINGLE	22m <sup>2</sup>	15m <sup>2</sup>	7m²
4	SINGLE	22m <sup>2</sup>	16m²	6m²
5	SINGLE	18m²	12m²	6m²
6	SINGLE	17m²	12m <sup>2</sup>	5m²
7	DOUBLE	19m²	14m²	5m <sup>2</sup>
8	DOUBLE	23m <sup>2</sup>	16m²	7m²
9	DOUBLE	22m <sup>2</sup>	13m²	9m²
10	SINGLE	18m²	11m²	7m²
11	DOUBLE	21m²	15m²	6m <sup>2</sup>
12	DOUBLE	24m²	19m²	5m²
NA	COMMUNAL ARI	EA 18m <sup>2</sup>		

## **FIRST FLOOR - AREA CALCULATIONS**

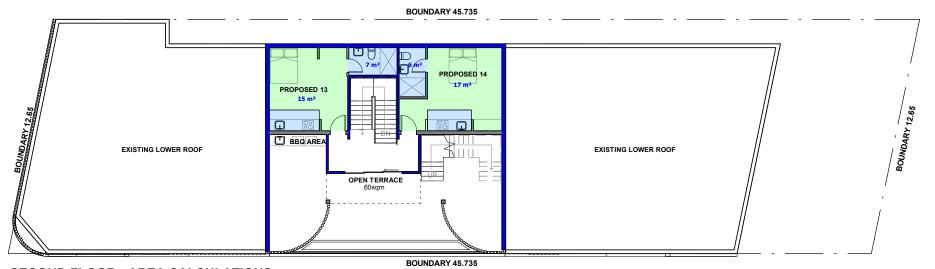

NOTE

# UNIT SCHEDULE SECOND FLOOR

PROPOSED NO.	TYPE	INTERNAL AREA	ROOM AREA	WET AREA
13	DOUBLE	22m²	15m²	7m <sup>2</sup>
14	DOUBLE	23m <sup>2</sup>	17m <sup>2</sup>	6m <sup>2</sup>

# **SECOND FLOOR - AREA CALCULATIONS**



A C C R E D I T E D BUILDING DESIGNER

ISSUE DATE PURPOSE OF ISSUE

1246 CANTERBURY ROAD, ROSELANDS NSW 2196

CLIENT

PROJECT

STATUS
FOR APPROVAL

STAGE DA N

DRAWING NO. ISSUE

DA-500 A

SCALE JOB NO.
1:200 21433


DATE DRAWING TITLE
03.03.2025 Calculations - GFA

DRAWN BY

CHECKED BY

WB

RΖ

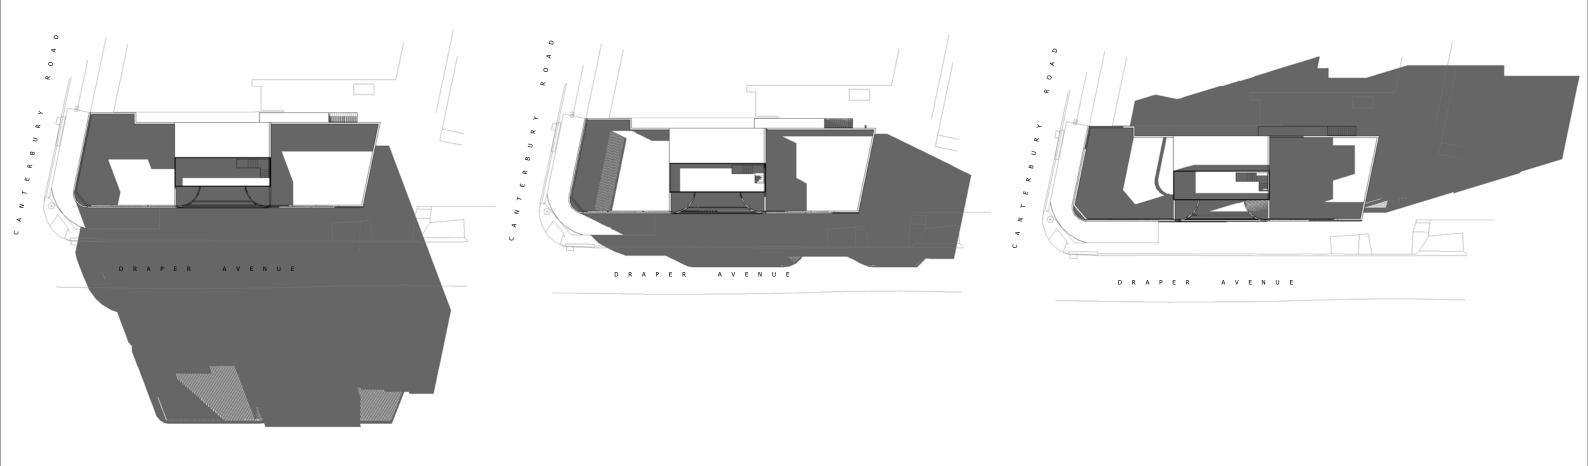

**3PM 21 JUNE - SHADOWS 9AM 21 JUNE - SHADOWS** 12PM 21 JUNE - SHADOWS



309A Forest Rd, Hurstville NSW 2220 ph: +61 2 8098 7886 fx: +61 2 8098 7886 e: admin@zta.net.au ZT ARCHITECTS PTY LTD ABN 87 655 327 049

ACCREDITED BUILDING DESIGNER

NOTE

ISSUE

DATE

PURPOSE OF ISSUE

CLIENT

STATUS **PROJECT** 1246 CANTERBURY ROAD, ROSELANDS NSW 2196 FOR APPROVAL

STAGE

DRAWING NO.

**DA-600** SCALE

1:500

DATE

DRAWN BY WB

JOB NO. CHECKED BY 21433 RΖ

DRAWING TITLE 03.03.2025 Shadows - Plans

ISSUE

Α





309A Forest Rd, Hurstville NSW 2220

ph: +61 2 8098 7886 fx: +61 2 8098 7886 e: admin@zta.net.au ZT ARCHITECTS PTY LTD

ABN 87 655 327 049

ACCREDITED BUILDING DESIGNER NOTE

ISSUE DATE PURPOSE OF ISSUE

PROJECT 1246 CANTERBURY ROAD, ROSELANDS NSW 2196

CLIENT

STATUS FOR APPROVAL

STAGE DA

DRAWING NO.

**DA-701** 

ISSUE DRAWN BY WB Α

SCALE

JOB NO. CHECKED BY

21433 RΖ

DATE DRAWING TITLE 03.03.2025 3D Visual





309A Forest Rd, Hurstville NSW 2220 ph: +61 2 8098 7886 fx: +61 2 8098 7886

e: admin@zta.net.au ZT ARCHITECTS PTY LTD ABN 87 655 327 049

ACCREDITED BUILDING DESIGNER NOTE

ISSUE DATE PURPOSE OF ISSUE

PROJECT 1246 CANTERBURY ROAD, ROSELANDS NSW 2196

CLIENT

FOR APPROVAL

STAGE DA

DRAWING NO.

**DA-702** 

ISSUE DRAWN BY WB Α

SCALE

JOB NO. CHECKED BY

RΖ

DATE DRAWING TITLE 03.03.2025 3D Visual

21433





309A Forest Rd, Hurstville NSW 2220

ph: +61 2 8098 7886 fx: +61 2 8098 7886 e: admin@zta.net.au ZT ARCHITECTS PTY LTD ABN 87 655 327 049

ACCREDITED BUILDING DESIGNER NOTE

ISSUE DATE PURPOSE OF ISSUE

PROJECT

1246 CANTERBURY ROAD, ROSELANDS NSW 2196

CLIENT

STATUS

FOR APPROVAL

STAGE DA

DRAWING NO.

**DA-703** 

SCALE

ISSUE DRAWN BY WB Α

JOB NO. CHECKED BY RΖ

21433

DATE 03.03.2025

DRAWING TITLE 3D Visual